

Construction Plans and Specifications Of **WARNER CREEK IMPROVEMENTS SAVANNAS WEIR** For **MARTIN COUNTY** Lying In



Project No. 1477.26 WARNER CREEK IMPROVEMENTS



Location Map

Section 21, Township 37 S. , Range 41 E. Martin County, Florida

NOTES:

THESE PLANS ARE IN ENGLISH UNITS
ALL ELEVATIONS HEREIN REFERENCE N.A.V.D.
1988 DATUM. ADD 1.48 FEET TO CONVERT TO
N.G.V.D. 1929 DATUM. ALL CONSTRUCTION IS TO
BE IN ACCORDANCE WITH FLORIDA DEPARTMENT
OF TRANSPORTATION STANDARDS AND
SPECIFICATIONS.

BOARD OF COUNTY COMMISSIONERS

DOUG SMITH
ED FIELDING
HAROLD JENKINS
SARAH HEARD
ED CIAMPI

DISTRICT 1
DISTRICT 2
DISTRICT 3
DISTRICT 4
DISTRICT 5


ENGINEER

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CAPTEC ENGINEERING, INC.
301 N.W. FLAGLER AVENUE
STUART, FLORIDA 34994
PHONE: (772)-692-4344
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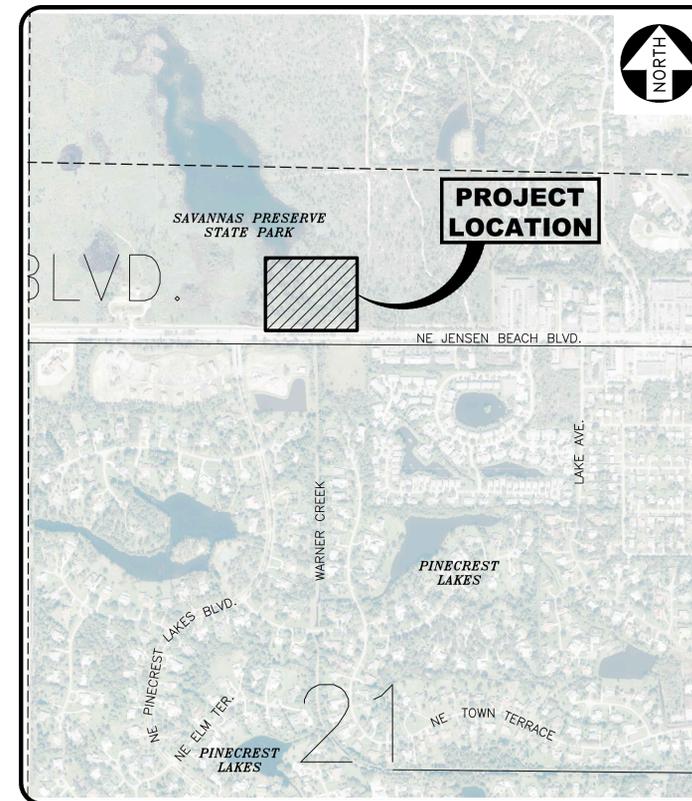
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Engineering Business
No. EB-007657



Vicinity Map
N.T.S.

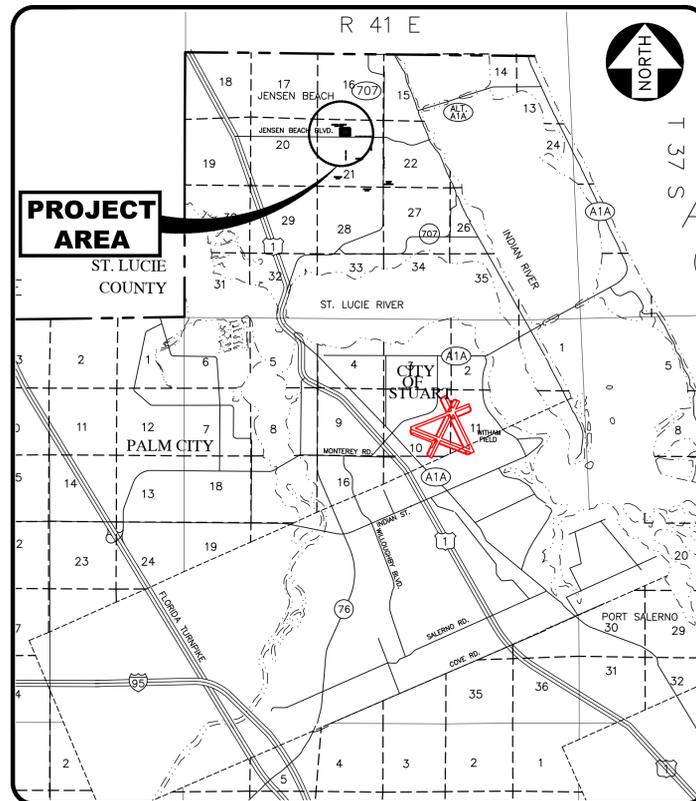



Site Map
N.T.S.

SHEET INDEX

SHEET NUMBER	SHEET TITLE/DESCRIPTION
01	COVER
02	OVERALL SITE PLAN
03	SAVANNAS WEIR DETAIL
04	SECTIONS AND DETAILS
05	GENERAL NOTES

BID SET
12/21/17



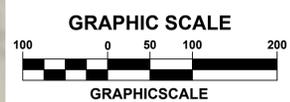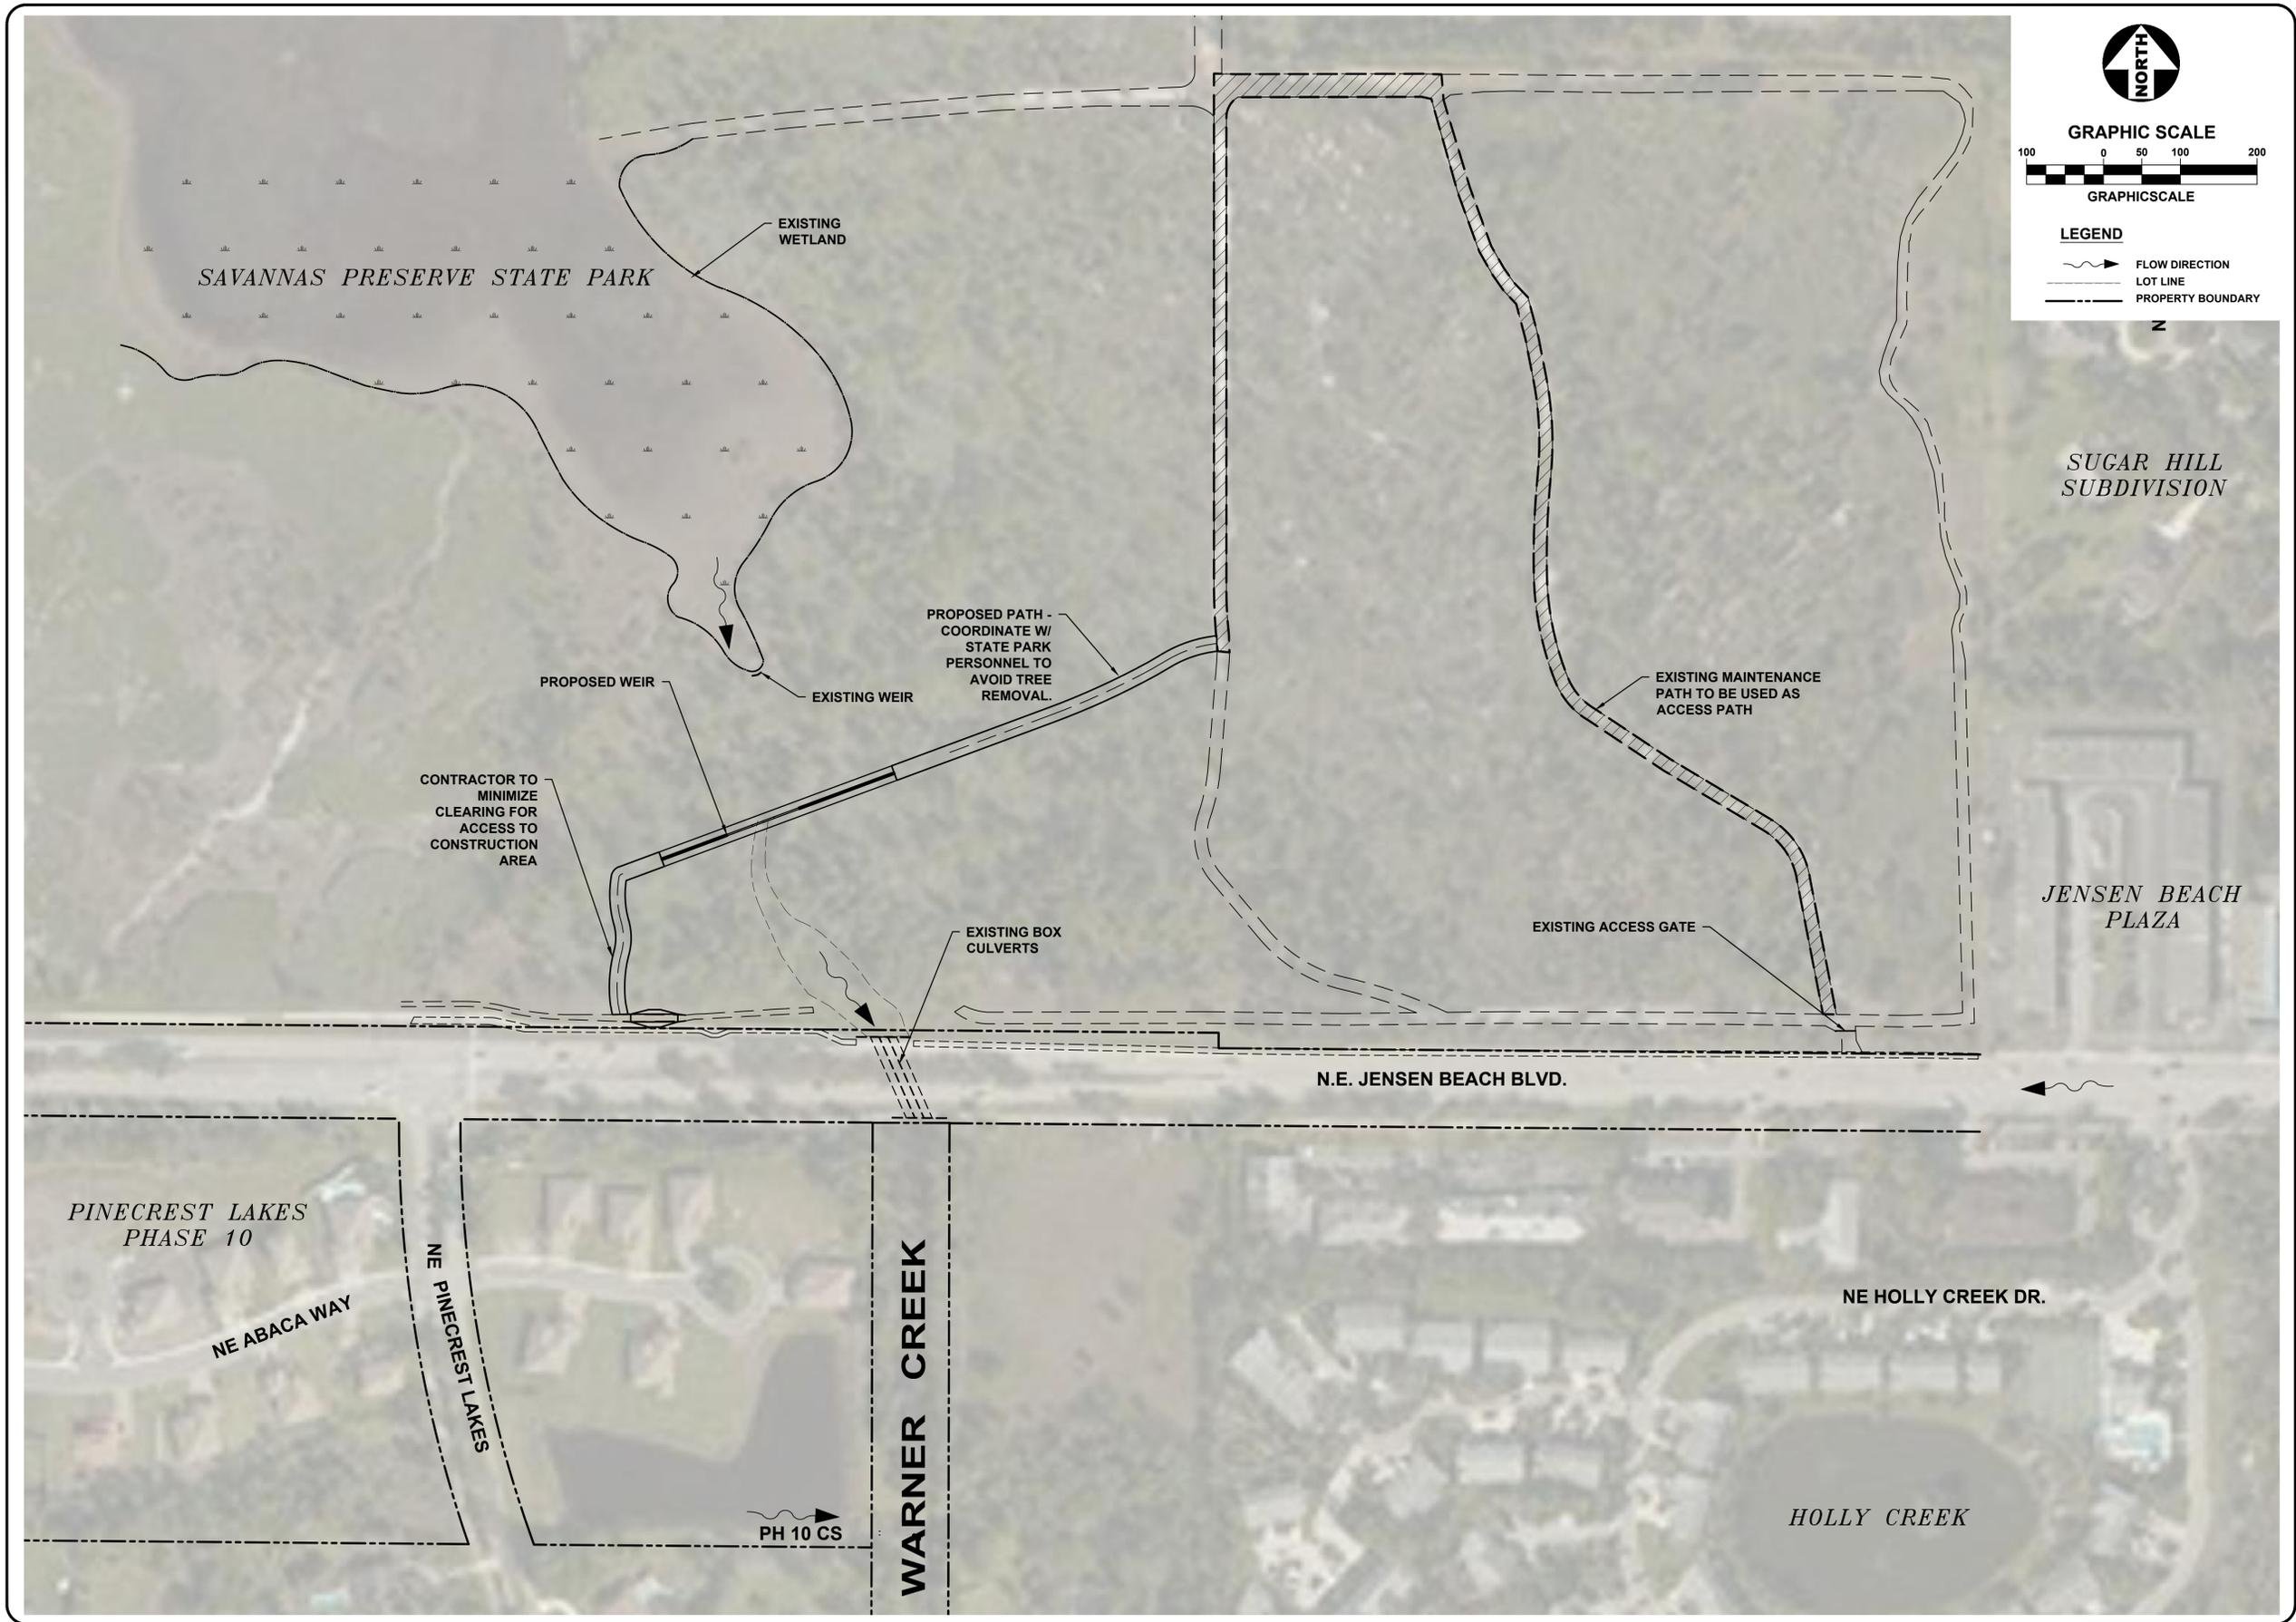

- LEGEND**
- FLOW DIRECTION
 - LOT LINE
 - PROPERTY BOUNDARY

SUGAR HILL
SUBDIVISION

JENSEN BEACH
PLAZA

N.E. JENSEN BEACH BLVD.

NE HOLLY CREEK DR.

PINECREST LAKES
PHASE 10

NE ABACA WAY

NE PINECREST LAKES

WARNER CREEK

HOLLY CREEK

PH 10 CS

301 NW Flagler Ave. Ste. 201
Stuart, Florida 34984
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CAPTEC Engineering, Inc.
Civil Engineering Professionals

Engineering Business
No. EB-000767

DATE: 12/21/2017

DRAWN BY:	MWH
DESIGNED BY:	RRK
CHECKED BY:	RRK
PROJECT No.:	1477.26
HORIZ. SCALE:	1"=200'
VERT. SCALE:	N/A

CADD FILE: Overall Site Plan

NO.	DATE	BY	REVISIONS

SCALE VERIFICATION

1
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SOLID BAR IS EQUAL TO ONE INCH LONG. ADJUST ALL SCALED DIMENSIONS ACCORDINGLY


**WARNER CREEK IMPROVEMENTS
SAVANNAS WEIR
MARTIN COUNTY, FLORIDA
OVERALL SHEET
AND ACCESS PLAN**

Rhett R. Keene, P.E.
301 N.W. Flagler Ave.
Stuart, Florida 34984
P.E. No. 65626

Printed Date:

JOB No.: 1477.26
SHEET
02 OF 05

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LEGEND

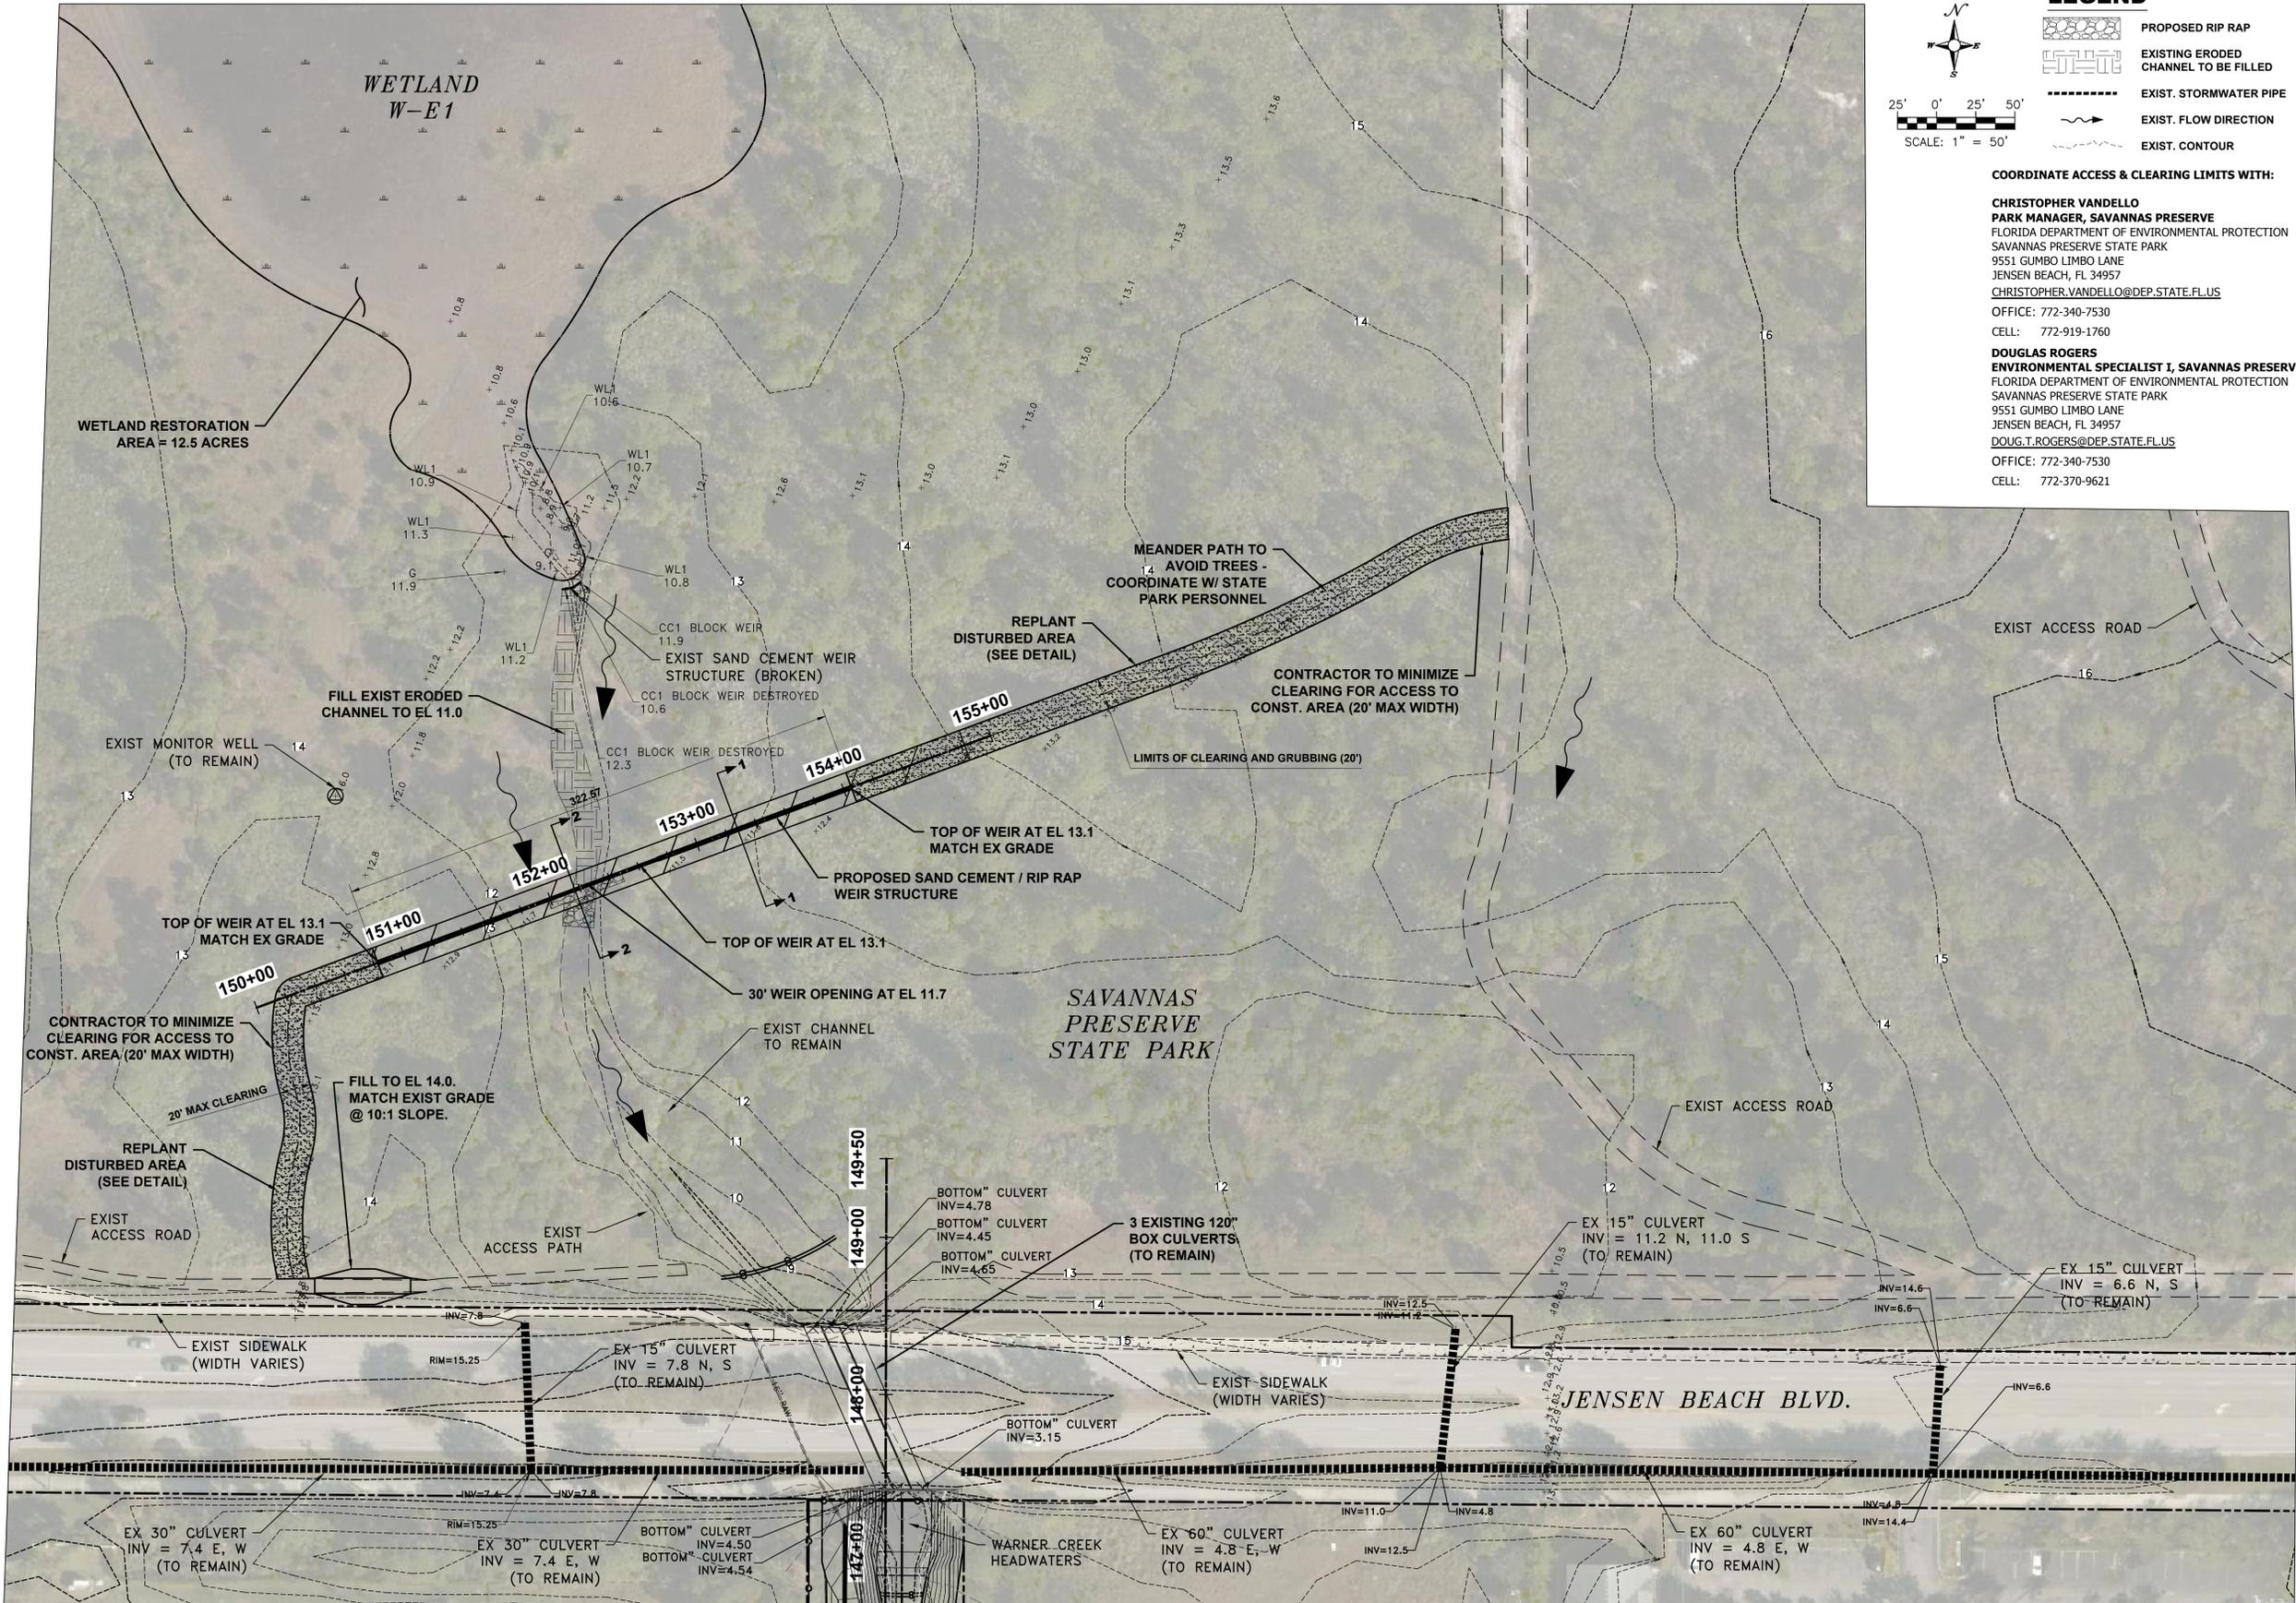- PROPOSED RIP RAP
- EXISTING ERODED CHANNEL TO BE FILLED
- EXIST. STORMWATER PIPE
- EXIST. FLOW DIRECTION
- EXIST. CONTOUR

SCALE: 1" = 50'

COORDINATE ACCESS & CLEARING LIMITS WITH:

CHRISTOPHER VANDELLO
 PARK MANAGER, SAVANNAS PRESERVE
 FLORIDA DEPARTMENT OF ENVIRONMENTAL PROTECTION
 SAVANNAS PRESERVE STATE PARK
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Engineer/Professional
 No. EB-0007627

DATE: 12/21/2017

DRAWN BY:	MMH	CHECKED BY:	RRK
DESIGNED BY:	RRK	PROJECT NO.:	1477.26
		HORIZ. SCALE:	1" = 50'
		VERT. SCALE:	1" = 8'

CADD FILE: 172613.PLT (VIEW)

NO.	DATE	BY	REVISIONS

SCALE VERIFICATION

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SOLID BAR IS EQUAL TO ONE INCH ON ORIGINAL DRAWING. ALL DIMENSIONS SHALL BE ACCORDINGLY.



WARNER CREEK IMPROVEMENTS
SAVANNAS WEIR
 MARTIN COUNTY
SAVANNAS WEIR DETAIL

RHETT R. KEENE
 301 N.W. Flagler Ave.
 Stuart, Florida 34994
 P.E. No. 65626


Printed Date:

JOB No.: **1477.26**
 SHEET
03 OF **05**

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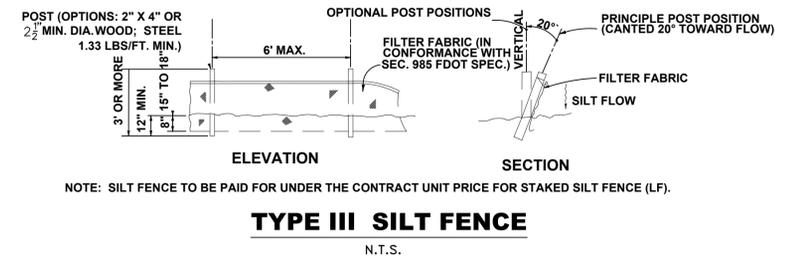


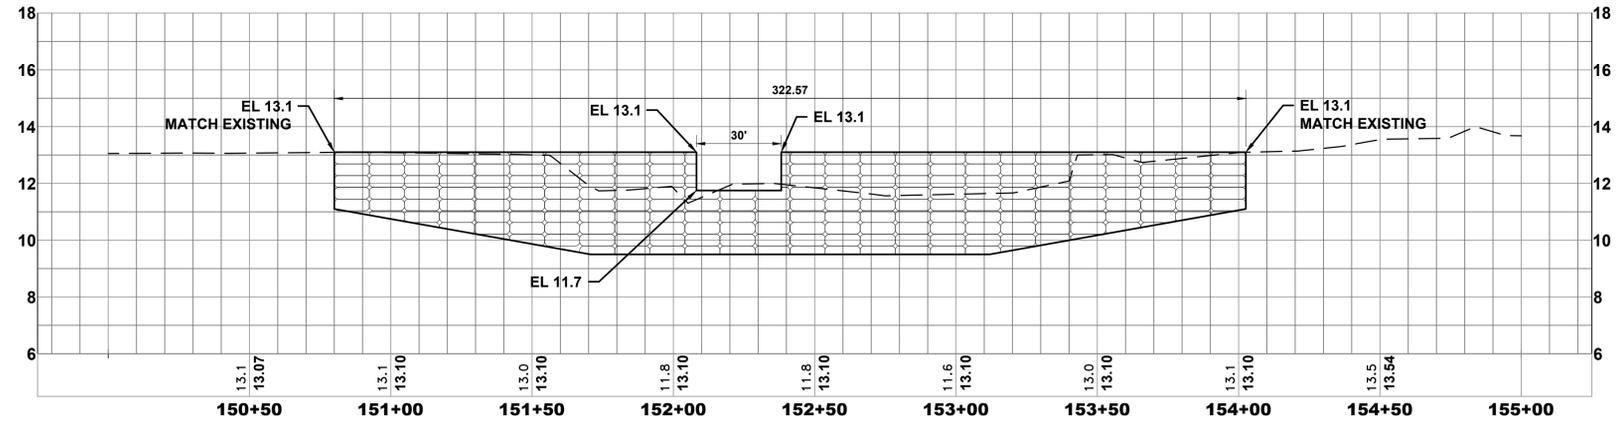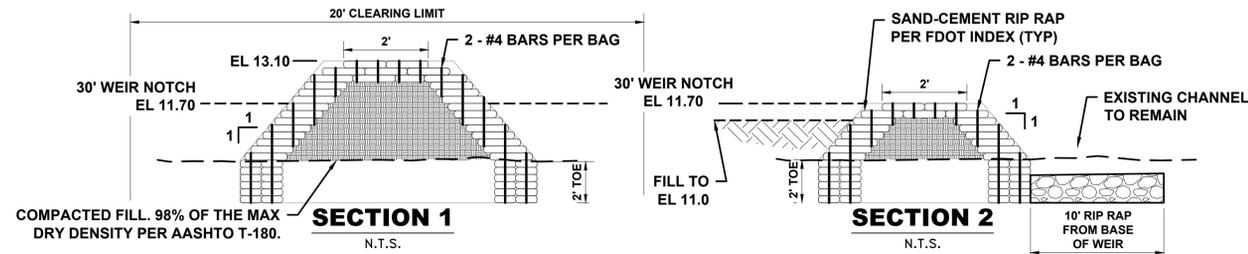PROFILE
N.T.S.

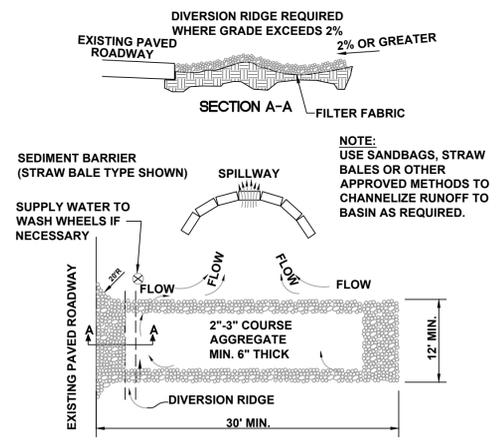


- NOTES:**
1. THE ENTRANCE SHALL BE MAINTAINED IN A CONDITION THAT WILL PREVENT TRACKING OR FLOWING OF SEDIMENT ONTO PUBLIC RIGHTS-OF-WAY. THIS MAY REQUIRE TOP DRESSING, REPAIR AND/OR CLEANOUT OF ANY MEASURES USED TO TRAP SEDIMENT.
 2. WHEN NECESSARY, WHEELS SHALL BE CLEANED PRIOR TO ENTRANCE ONTO PUBLIC RIGHTS-OF-WAY.
 3. WHEN WASHING IS REQUIRED, IT SHALL BE DONE ON AN AREA STABILIZED WITH CRUSHED STONE THAT DRAINS INTO AN APPROVED SEDIMENT BASIN.

STABILIZED CONSTRUCTION ENTRANCE




TYPE III SILT FENCE
N.T.S.

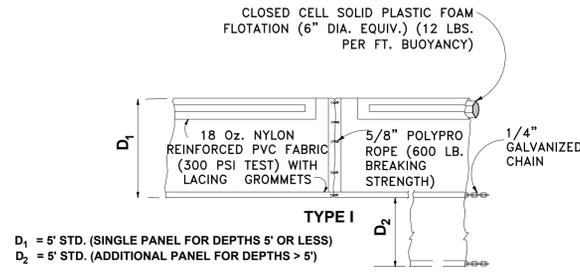

NOTICE: COMPONENTS OF TYPES I AND II MAY BE SIMILAR OR IDENTICAL TO PROPRIETARY DESIGNS. ANY INFRINGEMENT ON THE PROPRIETARY RIGHTS OF THE DESIGNER SHALL BE THE SOLE RESPONSIBILITY OF THE USER. SUBSTITUTIONS FOR TYPES I AND II SHALL BE AS APPROVED BY THE ENGINEER.


FLOATING TURBIDITY BARRIERS
N.T.S.

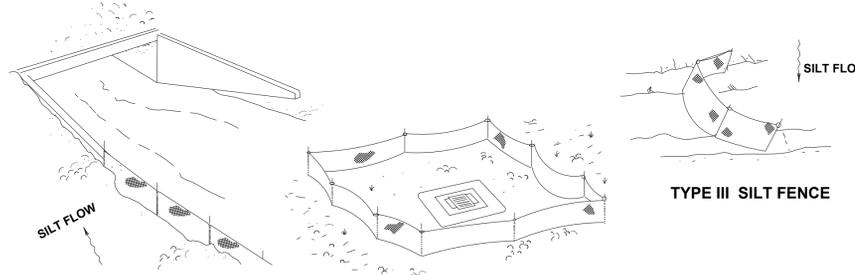

TYPE III SILT FENCE PROTECTION AROUND DITCH BOTTOM INLETS.

DO NOT DEPLOY IN A MANNER THAT SILT FENCES WILL ACT AS A DAM ACROSS PERMANENT FLOWING WATERCOURSES. SILT FENCES ARE TO BE USED AT UPLAND LOCATIONS AND TURBIDITY BARRIERS USED AT PERMANENT BODIES OF WATER.

SILT FENCE APPLICATIONS
N.T.S.

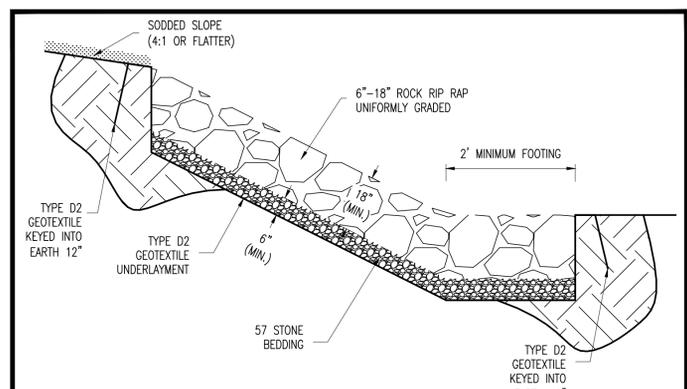

- NOTES:**
1. RIP RAP SHALL HAVE 6" MINIMUM 57 STONE BEDDING OVER TYPE D2 GEOTEXTILE.
 2. RIP RAP SHALL BE COQUINA ROCK (MINIMUM SPECIFIC GRAVITY ≥ 2.3) UNIFORMLY GRADED AND TIGHTLY INTERLOCKED
 3. TYPE D2 GEOTEXTILE SHALL BE KEYED INTO THE NATURAL EARTH AT TOP OF BANK AND TOE OF SLOPE A MINIMUM OF 12"

MARTIN COUNTY ENGINEERING - STANDARD DETAILS
RIP RAP
DETAIL R-38
DATE: 12/20/16

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Engineers & Surveyors
No. EB-0007627

DATE: 12/20/16
DRAWN BY: MMH
DESIGNED BY: RRK
CHECKED BY: RRK
PROJECT NO.: 1477.26
HORIZ. SCALE: 1" = 50'
VERT. SCALE: N/A
CADD FILE: 1477.26-03.PLT (WEB)

NO.	DATE	BY	REVISIONS

SCALE VERIFICATION
0 1
SOLID BAR IS EQUAL TO ONE INCH ON ORIGINAL DRAWING. ALL DIMENSIONS SHALL BE ACCORDINGLY.

WARNER CREEK IMPROVEMENTS
SAVANNAS WEIR
MARTIN COUNTY
SECTIONS AND DETAILS

RHETT R. KEENE
301 N.W. Flagler Ave.
Stuart, Florida 34994
P.E. No. 65626

GENERAL NOTES

- 1. ANY DISCREPANCIES ON THE DRAWINGS SHALL BE BROUGHT TO THE ATTENTION OF THE ENGINEER... 2. THE CONTRACTOR SHALL NOTIFY ALL AFFECTED UTILITY COMPANIES 14 DAYS PRIOR TO CONSTRUCTION... 3. THE LOCATION AND SIZE OF ALL EXISTING UTILITIES SHOWN ON THE PLANS ARE APPROXIMATE AND ARE BASED ON THE BEST AVAILABLE INFORMATION... 4. THE CONTRACTOR SHALL PROTECT ALL EXISTING ABOVE OR UNDERGROUND STRUCTURES, LANDSCAPE FEATURES, TREES AND UTILITIES NOT SHOWN ON THE PLANS TO BE REMOVED BY CONSTRUCTION... 5. PROJECT SUPERINTENDENT: THE CONTRACTOR SHALL PROVIDE A QUALIFIED SUPERINTENDENT TO REMAIN ON THE JOB SITE AT ALL TIMES WHEN WORK IS BEING PERFORMED... 6. IT IS THE CONTRACTOR'S RESPONSIBILITY TO ENSURE HIS COMPLETE FAMILIARITY WITH THE PROJECT SITE AND COMPONENTS TO INCLUDE SUBSURFACE CONDITIONS OF SOIL AND GROUNDWATER TABLE... 7. THE "TRENCH SAFETY ACT" SHALL BE INCORPORATED INTO THIS CONTRACT AS ENACTED BY THE LEGISLATURE OF THE STATE OF FLORIDA TO BE IN EFFECT AS OF OCTOBER 1, 1996... 8. AS-BUILT PLANS: THE CONTRACTOR SHALL PROVIDE ONE (1) REPRODUCIBLE MYLAR COPY, FIFTEEN (15) BLACK LINE COPIES AND ONE (1) DIGITAL FORMAT OF A CERTIFIED AS-BUILT SURVEY... 9. THE CONTRACTOR WILL SUBMIT FOR APPROVAL BY MARTIN COUNTY A PLAN SHOWING THE SCHEDULE OF WORK, INCLUDING A HIGHLIGHTED PLAN SHOWING THE ORDER OF CONSTRUCTION WHICH WILL FACILITATE MAINTAINING EXISTING SERVICE ACCESS DURING CONSTRUCTION... 10. ALL CONSTRUCTION IS TO BE IN ACCORDANCE WITH THE REQUIREMENTS OF MARTIN COUNTY CODES AND REGULATIONS... 11. ANY GEODETIC MONUMENT WITHIN THE LIMITS OF CONSTRUCTION IS TO BE PROTECTED... 12. BENCH MARK DATA IS NATIONAL AMERICAN VERTICAL DATUM OF 1988 (NAVD 88)... 13. SHOP DRAWING SUBMITTAL APPROVALS ARE REQUIRED FOR ALL STRUCTURES... 14. CONTRACTOR TO MAINTAIN OR REPLACE ALL EXISTING PROPERTY CORNERS / MONUMENTS DISTURBED BY CONSTRUCTION ACTIVITY... 15. IF HISTORICAL OR ARCHAEOLOGICAL ARTIFACTS ARE DISCOVERED ON SITE, THE CONTRACTOR WILL IMMEDIATELY NOTIFY THE SOUTH FLORIDA WATER MANAGEMENT DISTRICT.

TURBIDITY NOTE

THE CONTRACTOR SHALL PLACE TURBIDITY BARRIERS AT ALL OUTFALLS PRIOR TO CONSTRUCTION. ALL CUT/FILL WILL BE RELOCATED WITHIN THE EXISTING SITE AND THEREFORE HAULING OF MATERIAL WILL NOT BE REQUIRED. CONTRACTOR SHALL INSTALL TURBIDITY CONTROL MEASURES PRIOR TO COMMENCEMENT OF CONSTRUCTION AND MAINTAIN SAID CONTROLS IN WORKING ORDER THROUGHOUT THE CONSTRUCTION PERIOD, ASSURING THAT TURBID DISCHARGES FROM THE PROJECT TO PROTECTED WATERS AND WETLANDS DO NOT EXCEED 28 NTU'S ABOVE BACKGROUND LEVELS AND REMOVE SAID CONTROLS AFTER COMPLETION OF CONSTRUCTION.

SOD

THE SOD SHALL BE CERTIFIED TO MEET FLORIDA STATE PLANT BOARD SPECIFICATIONS, ABSOLUTELY TRUE TO VARIETAL TYPE AND FREE FROM WEEDS, FUNGUS, INSECTS AND DISEASE OF ANY KIND. ALL SODDED AREAS SHALL BE GRESSED AS SPECIFIED ON PLANS AND SURVIVAL GUARANTEED FOR NINETY DAYS FROM DATE OF REPLACEMENT. ALL SOD TO MATCH EXISTING.

FILTER FABRIC

THE CONTRACTOR SHALL WRAP ALL STORM PIPE JOINTS. CONSTRUCTION SHALL BE PER F.D.O.T. INDEX NO. 280 WITH WOVEN GEOTEXTILE TYPE D-3 (F.D.O.T. INDEX NO. 199), SECURED W/STRAPPING. ALL JOINTS SHALL BE WRAPPED FOR A MINIMUM OF 18 INCHES FROM THE BAND OR JOINT OR BELL AND SPIGOT AS APPLICABLE.

RIP-RAP

- 1. ROCK SHALL BE LOCAL COQUINA BOULDERS PLACED IN AN 24" AVERAGE THICKNESS. ROCK SHALL BE UNDERLAIN WITH FILTER FABRIC TOED 18" INTO EACH AT PERIMETER OF RIPRAP MAT... 2. ROCK SHALL BE GRADED IN SIZE TO PRODUCE A REASONABLY DENSE MASS... 3. ROCK SHALL BE "CHINKED" WHEN PLACED SUCH THAT SMALLER STONES ARE SET BETWEEN LARGER STONES... 4. ROCK RIPRAP SHALL HAVE LESS THAN 10% LOSS OF WEIGHT AFTER FIVE CYCLES, WHEN TESTED PER ASTM C535... 5. RIPRAP ROCK SHALL HAVE A WEAR NOT GREATER THAN 40%, WHEN TESTED PER ASTM C88... 6. NEITHER THE BREADTH NOR THICKNESS OF ANY PIECE OF RIPRAP SHALL BE LESS THAN ONE-THIRD ITS LENGTH.

SOIL EROSION PLAN

- 1. NO POLLUTION OR EROSION CAUSED BY THIS PROJECT WILL BE ALLOWED IN THE STORMWATER DRAINAGE SYSTEM... 2. PRIOR TO CONSTRUCTION, THE CONTRACTOR SHALL SUBMIT A SPECIFIC SOIL EROSION PLAN... 3. ALL TEMPORARY GRAVEL ENTRANCES SHALL BE MAINTAINED IN A CONDITION THAT WILL PREVENT TRACKING OR FLOWING OF SEDIMENT ONTO PUBLIC RIGHTS-OF-WAY... 4. WHEN NECESSARY, WHEELS SHALL BE CLEANED PRIOR TO ENTRANCE ONTO PUBLIC RIGHT-OF-WAY... 5. THE CONTRACTOR SHALL APPLY APPROPRIATE BMP'S TO CONTROL WIND EROSION.

WATER QUALITY NOTES

- 1. THE CONTRACTOR MUST MAINTAIN A COPY OF THE LATEST LOCAL WATER MANAGEMENT DISTRICT SURFACE WATER PERMIT... 2. ALL ACTIVITIES SHALL BE IMPLEMENTED AS SET FORTH IN THE PLANS, SPECIFICATIONS AND PERFORMANCE CRITERIA AS APPROVED BY LOCAL SURFACE WATER PERMIT... 3. THE LOCAL WATER MANAGEMENT DISTRICT AUTHORIZED STAFF, UPON PROPER IDENTIFICATION, MUST BE GRANTED PERMISSION TO ENTER, INSPECT AND OBSERVE THE SYSTEM TO INSURE CONFORMITY WITH THE PLANS AND SPECIFICATIONS... 4. PRIOR TO AND DURING CONSTRUCTION, THE CONTRACTOR SHALL IMPLEMENT AND MAINTAIN ALL EROSION AND SEDIMENT CONTROL MEASURES... 5. STABILIZATION MEASURES SHALL BE INITIATED FOR EROSION AND SEDIMENT CONTROL ON DISTURBED AREAS AS SOON AS PRACTICABLE... 6. THE STORMWATER MANAGEMENT SYSTEM MUST BE COMPLETE IN ACCORDANCE WITH THE PERMITTED PLANS AND PERMIT CONDITIONS... 7. IF DEWATERING IS TO OCCUR DURING ANY PHASE OF CONSTRUCTION OR THEREAFTER AND THE SURFACE WATER PUMPS, WELLS OR FACILITIES ARE CAPABLE OF WITHDRAWING ONE MILLION GALLONS OF WATER PER DAY OR MORE... 8. MONITORING SHALL BE PERFORMED DAILY. SAMPLING TO TAKE PLACE AT POINT OF DISCHARGE MEASURING FOR TURBIDITY, 100 FT DOWNSTREAM OF DISCHARGE.

GROUNDWATER

HEAVY RAINFALL AND/OR A HIGH WATER TABLE MAY OCCUR BEFORE THE EARTHWORK COMMENCES, OR DURING THE EARTHWORK. IF THESE CONDITIONS OCCUR AND THE SITE PREPARATION CANNOT BE ACHIEVED AS SPECIFIED, AN EXCAVATION OF THE EXISTING CONDITIONS SHOULD BE CONDUCTED AND THE SPECIFICATIONS REVISED ACCORDINGLY.

EARTHWORK AND RELATED OPERATIONS

- 1. THE CONTRACTOR SHALL PROVIDE A QUALITY CONTROL PLAN FOR MONITORING OF ALL EARTHWORK AND RELATED OPERATIONS... 2. THE TESTING LABORATORY THAT IS RETAINED TO PERFORM THE CONTRACTOR'S QUALITY CONTROL TESTING MUST BE CERTIFIED BY A RECOGNIZED QUALIFYING AGENCY... 3. THE QUALITY CONTROL PLAN SHALL BE SUBMITTED TO THE ENGINEER FOR REVIEW AND APPROVAL... 4. UTILIZATION OF MATERIALS WITHIN THE ROADWAY CROSS SECTION SHALL BE IN ACCORDANCE WITH FDOT ROADWAY AND TRAFFIC DESIGN STANDARDS... 5. IF THE EXISTING FILL IS CLASSIFIED AS A-2-4 BASED ON AASHTO M 145 CRITERIA, THE MAXIMUM PERMISSIBLE MOISTURE CONTENT SHALL BE 2 PERCENT ABOVE THE OPTIMUM MOISTURE CONTENT.

GRADING NOTES

- 1. ALL AREAS SHALL BE CLEARED AND GRUBBED PRIOR TO CONSTRUCTION... 2. PRIOR TO CONSTRUCTION, THE CONTRACTOR SHALL SUBMIT A SPECIFIC SOIL EROSION PLAN... 3. ALL PROPOSED ELEVATIONS REFER TO FINISHED GRADES... 4. ALL DISTURBED DRAINAGE AREAS SHALL BE STABILIZED UPON COMPLETION OF GRADING... 5. ALL EXCAVATED MATERIAL SHALL BE USED ON-SITE... 6. THE CONTRACTOR SHALL CONSTRUCT THE STORM WATER MANAGEMENT SYSTEM IN A MANNER SO AS TO MINIMIZE ANY ADVERSE IMPACTS OF THE WORKS ON FISH, WILDLIFE, NATURAL ENVIRONMENTAL VALUES AND WATER QUALITY... 7. WITHIN THIRTY (30) DAYS AFTER COMPLETION OF CONSTRUCTION OF THE SURFACE WATER MANAGEMENT SYSTEM... 8. A STABLE PERMANENT AND ACCESSIBLE ELEVATION REFERENCE SHALL BE ESTABLISHED ON OR WITHIN ONE HUNDRED FEET (100') OF ALL PERMITTED DISCHARGE STRUCTURES... 9. EXCAVATED MATERIALS, SUCH AS BOULDERS AND LOGS THAT ARE NOT SUITABLE FOR BACKFILL, SHOULD BE REMOVED FROM SITE.

STANDARD SEPARATION FOR WATER / SEWER CONFLICTS

- 1. SANITARY SEWERS, FORCE MAIN AND STORM SEWERS SHOULD ALWAYS CROSS UNDER WATER MAIN... 2. A MINIMUM TEN FOOT HORIZONTAL SEPARATION SHALL BE MAINTAINED BETWEEN ANY TYPE OF SEWER AND WATER MAIN IN PARALLEL INSTALLATIONS... 3. ALL DIP SHALL BE CLASS B OR HIGHER, ADEQUATE PROTECTIVE MEASURES AGAINST CORROSION SHALL BE USED... 4. THE CONTRACTOR SHALL MAINTAIN THE JOB SITE IN A NEAT CONDITION AT ALL TIMES AND SHALL RESTORE/REPAIR ALL DRIVEWAYS, SIDEWALKS, UTILITIES, LANDSCAPING, IRRIGATION SYSTEMS, ETC., AFFECTED BY CONSTRUCTION ACTIVITIES.

CLEAN UP

- 1. THE CONTRACTOR SHALL MAINTAIN THE JOB SITE IN A NEAT CONDITION AT ALL TIMES AND SHALL RESTORE/REPAIR ALL DRIVEWAYS, SIDEWALKS, UTILITIES, LANDSCAPING, IRRIGATION SYSTEMS, ETC., AFFECTED BY CONSTRUCTION ACTIVITIES... 2. THE CONTRACTOR SHALL REMOVE ALL EXCESS MATERIALS, DEBRIS, EQUIPMENT, ETC., FROM THE JOB SITE IMMEDIATELY AFTER COMPLETION OF CONSTRUCTION OPERATIONS... 3. CONTRACTOR IS FURTHER REFERRED TO ARTICLE 6 SEC. 6.11 OF THE "STANDARD FEDERAL CONDITIONS OF THE CONSTRUCTION CONTRACT"... 4. UNLESS OTHERWISE SPECIFIED OR NOTED, ALL DISTURBED AREAS SHALL BE RESTORED BY CONTRACTOR TO PRE-CONSTRUCTION CONDITION OR BETTER PRIOR TO ACCEPTANCE BY MARTIN COUNTY.

301 N.W. Flagler Ave. Stuart, Florida 34984 Phone: (772) 692-4344 Fax: (772) 692-4341



Table with columns: DATE, DRAWN BY, DESIGNED BY, CHECKED BY, PROJECT NO., HORIZ. SCALE, VERT. SCALE, CAD FILE #

Table with columns: NO., DATE, BY, REVISIONS



WARNER CREEK IMPROVEMENTS SAVANNAS WEIR MARTIN COUNTY GENERAL NOTES

RHETT R. KEENE 301 N.W. Flagler Ave. Stuart, Florida 34984 P.E. No. 65626

Printed Date: JOB No.: 1477.26 SHEET 05 OF 05

UTILITIES COMPANIES

- FLORIDA POWER AND LIGHT 1650 SE BRANDON CIRCLE PORT ST. LUCIE, FL 34952 (772)337-7001 COMCAST 1495 BRITT RD. STUART, FL 34994 (772)692-9010 MARTIN COUNTY UTILITIES PO BOX 9000 STUART, FL 34995 (772)221-1442 MARTIN COUNTY TRAFFIC SERVICES 2244 SE FEDERAL HIGHWAY STUART, FL 34995 (772) 465-0207

SURVEYOR

MARTIN COUNTY ENGINEERING DEPT. SURVEY DIVISION 2401 S.E. MONTEREY ROAD STUART, FL 34996 (772)288-9927

GEOTECHNICAL ENGINEER

ANDERSEN ANDRE CONSULTING ENGINEERS 873 SW BILTMORE STREET PORT ST. LUCIE, FL 34983 (772)807-9191

ENVIRONMENTAL SERVICES

HOBE SOUND ENVIRONMENTAL SERVICES, INC. HOBE SOUND, FL 33455 (772) 465-3676

10 DAYS PRIOR TO CROSSING EXISTING UTILITIES, THE CONTRACTOR WILL POT HOLE THE LOCATION OF THE EXISTING UTILITY TO DETERMINE THE EXACT HORIZONTAL AND VERTICAL LOCATION.

POTHOLE ALL CONFLICTS 10 DAYS PRIOR TO CONSTRUCTION

ENGINEER OF RECORD INSPECTION REQUIREMENTS CONTRACTOR TO CALL CONTRACT ENGINEER OF RECORD 48 HOURS ADVANCE FOR FOLLOWING INSPECTIONS: 1. PRE-CONSTRUCTION MEETING 2. SIDEWALK FORM 3. PAVEMENT SUBGRADE 4. PAVEMENT BASE 5. FINAL



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